

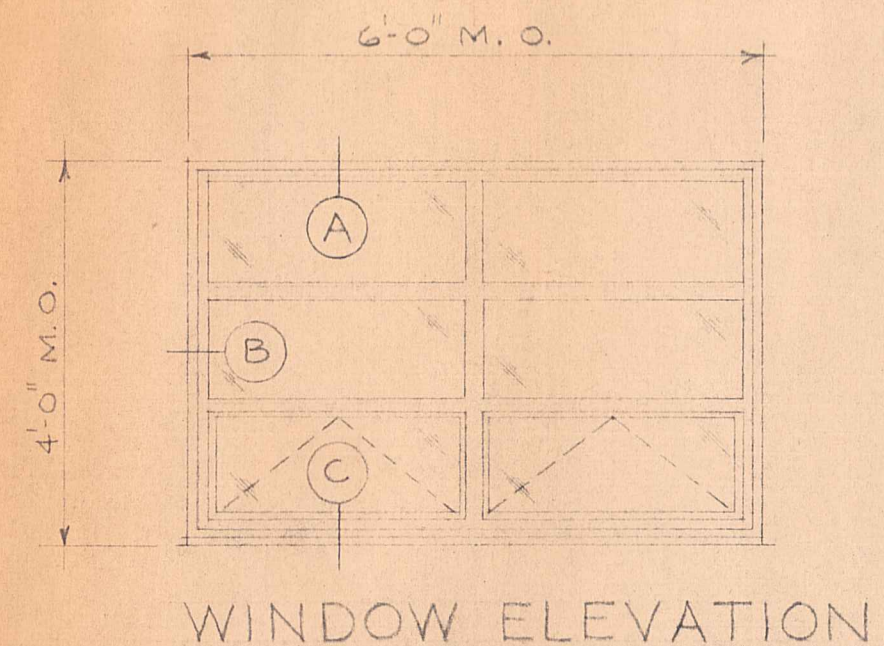
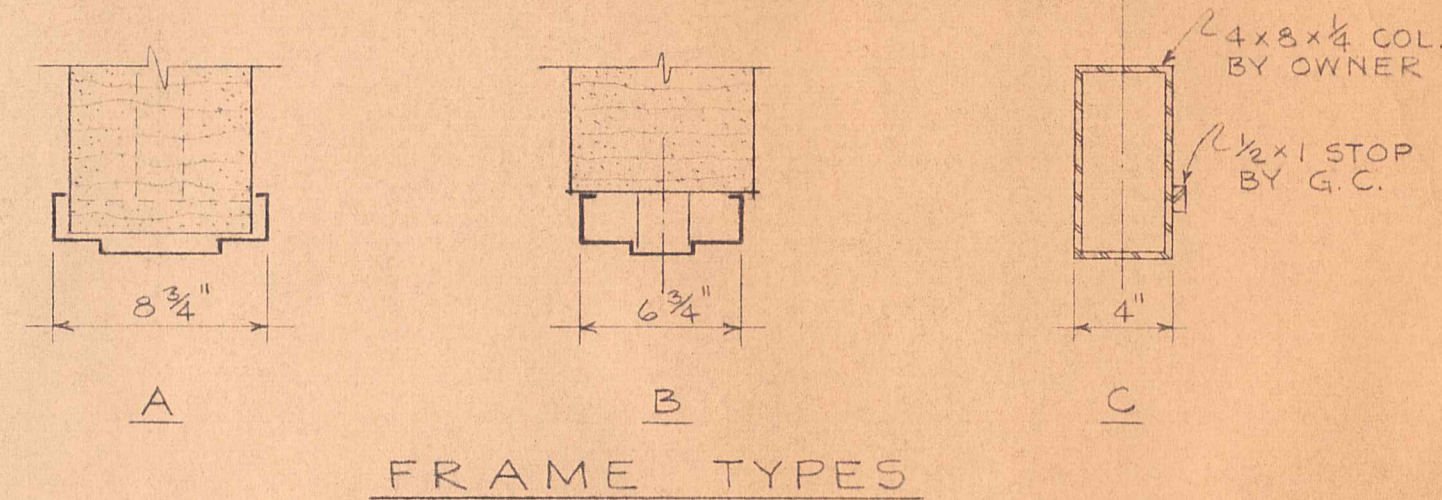


DOOR SCHEDULE							
DOOR	TYPE	WIDTH	HEIGHT	THICK	SADDLE	FRAME	REMARKS
1	B	3'-0"	6'-8"	1 3/4"	—	A	UNDERCUT 1"
2	A	3'-0"	6'-8"	1 3/4"	—	A	
3	A	3'-0"	6'-8"	1 3/4"	—	A	UNDERCUT 1"
4	B	3'-0"	6'-8"	1 3/4"	—	A	UNDERCUT 1"
5	A	3'-0"	6'-8"	1 3/4"	—	A	
6	B	6'-0" PR.	6'-8"	1 3/4"	—	A	
7	A	2'-8"	7'-2"	1 3/4"	B	B	WEATHERSTRIP
8	A	2'-8"	7'-2"	1 3/4"	B	B	WEATHERSTRIP
9	B	3'-0"	6'-8"	1 3/4"	—	A	
10	A	2'-6"	6'-8"	1 3/4"	A	C	WEATHERSTRIP
11	A	2'-6"	6'-8"	1 3/4"	A	C	WEATHERSTRIP
12	A	2'-6"	6'-8"	1 3/4"	A	C	WEATHERSTRIP


NOTES
 1. ALL DOORS AND FRAMES ARE TO BE HOLLOW METAL.
 2. USE LINTEL BLOCK ABOVE ALL DOOR FRAMES EXCEPT DOORS 10, 11 & 12. USE 2-#4 BARS FOR EACH LINTEL.

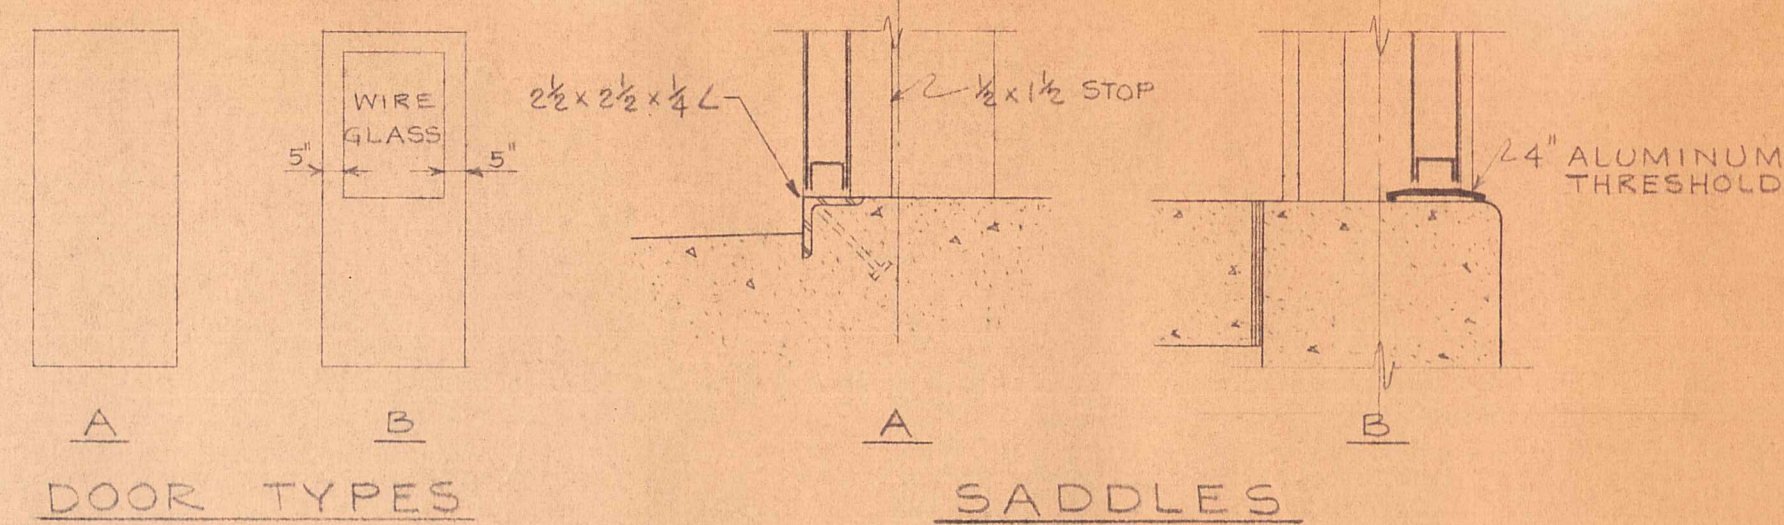


WINDOW ELEVATION

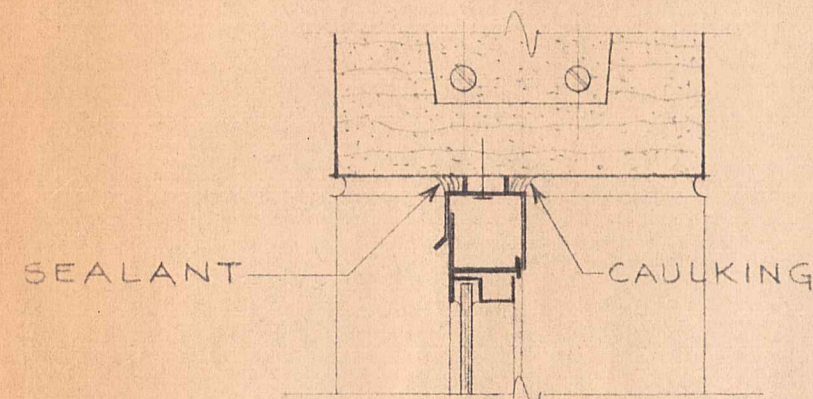


HEAD
3" = 1'-0" (A)

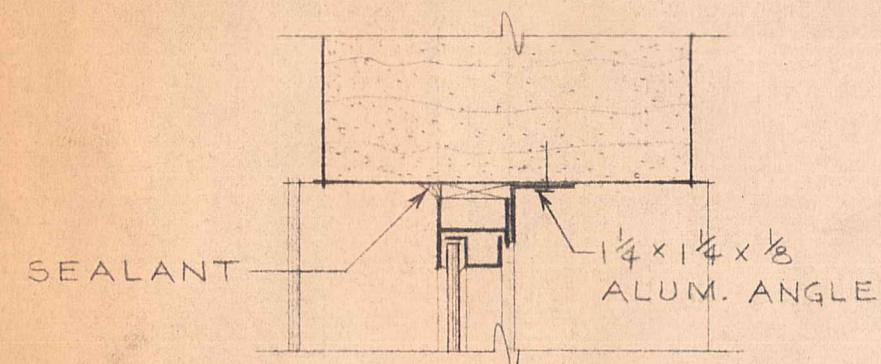


JAMB
3" = 1'-0" (B)

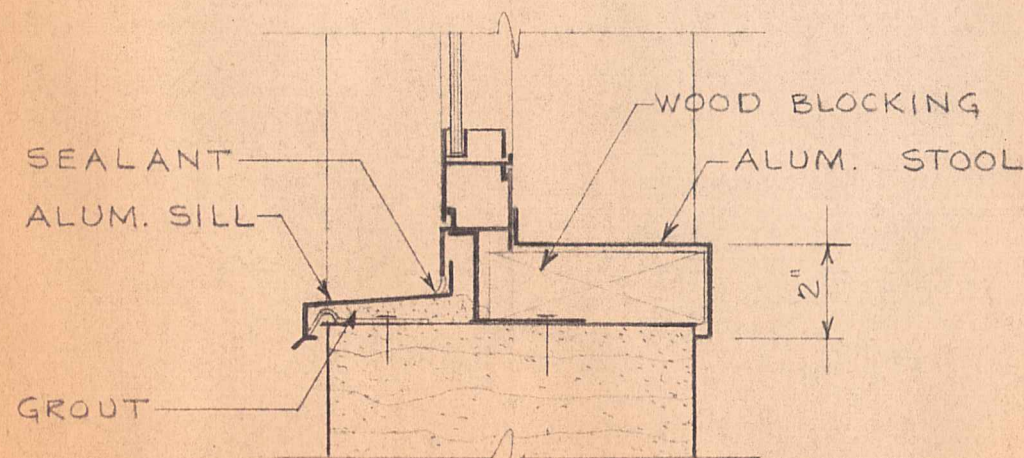


SILL
3" = 1'-0" (C)

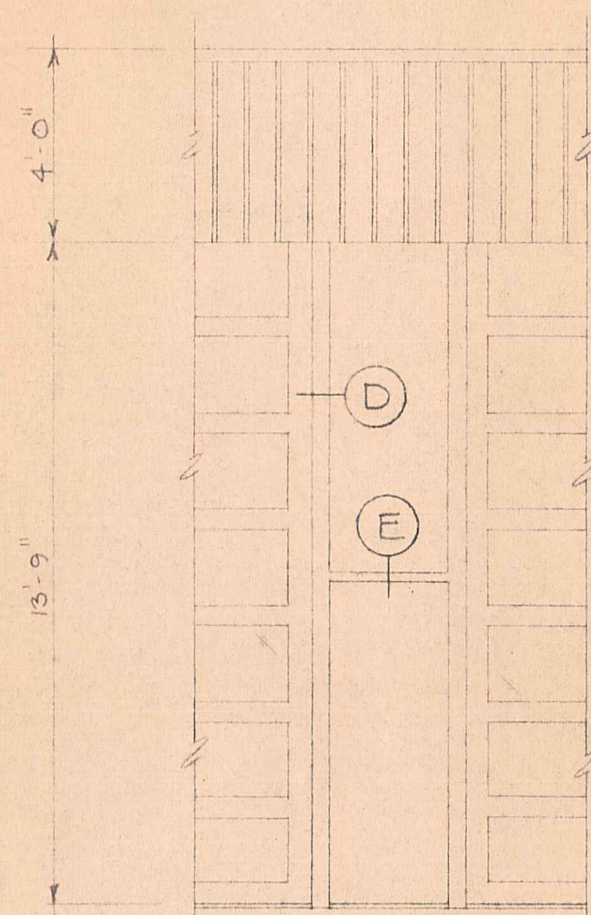


ELEVATION
4" = 1'-0"

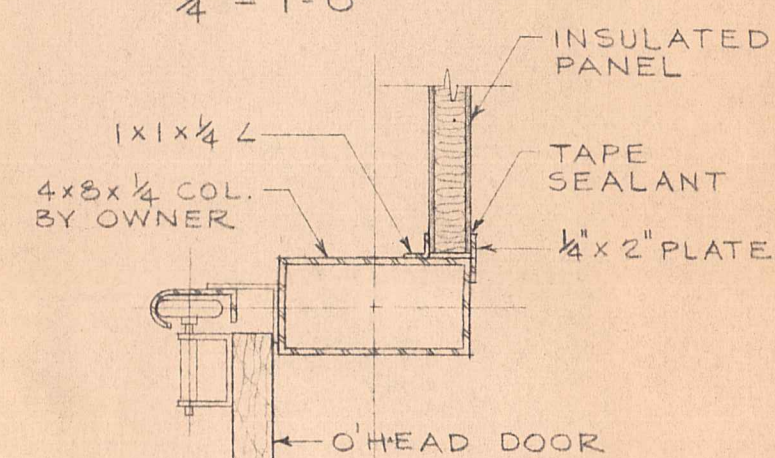


JAMB
1 1/2" = 1'-0" (D)

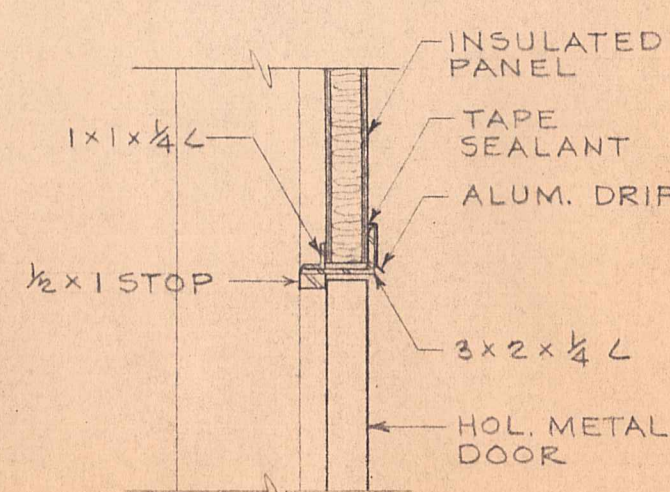


HEAD
1 1/2" = 1'-0" (E)

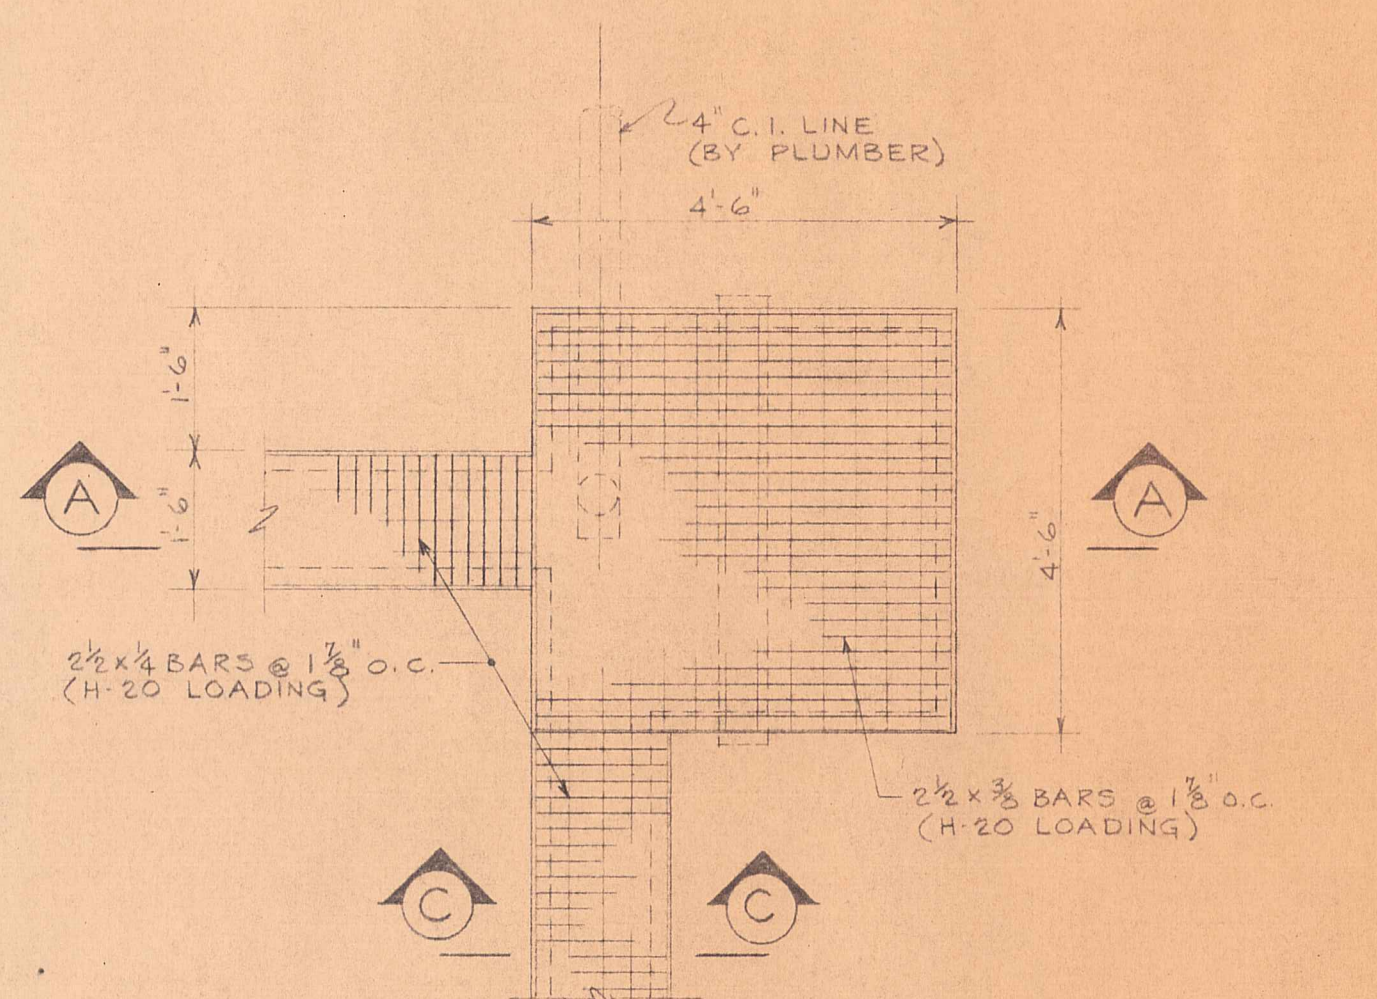


PLAN - SAND TRAP IN MAINTENANCE
1/2" = 1'-0"

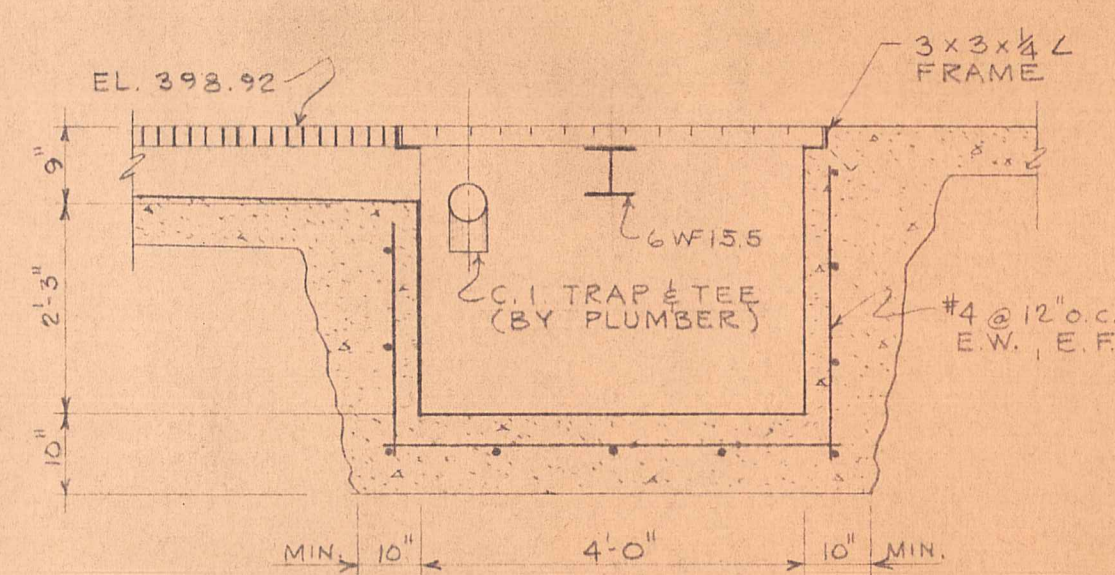


SECTION A-A
1/2" = 1'-0"

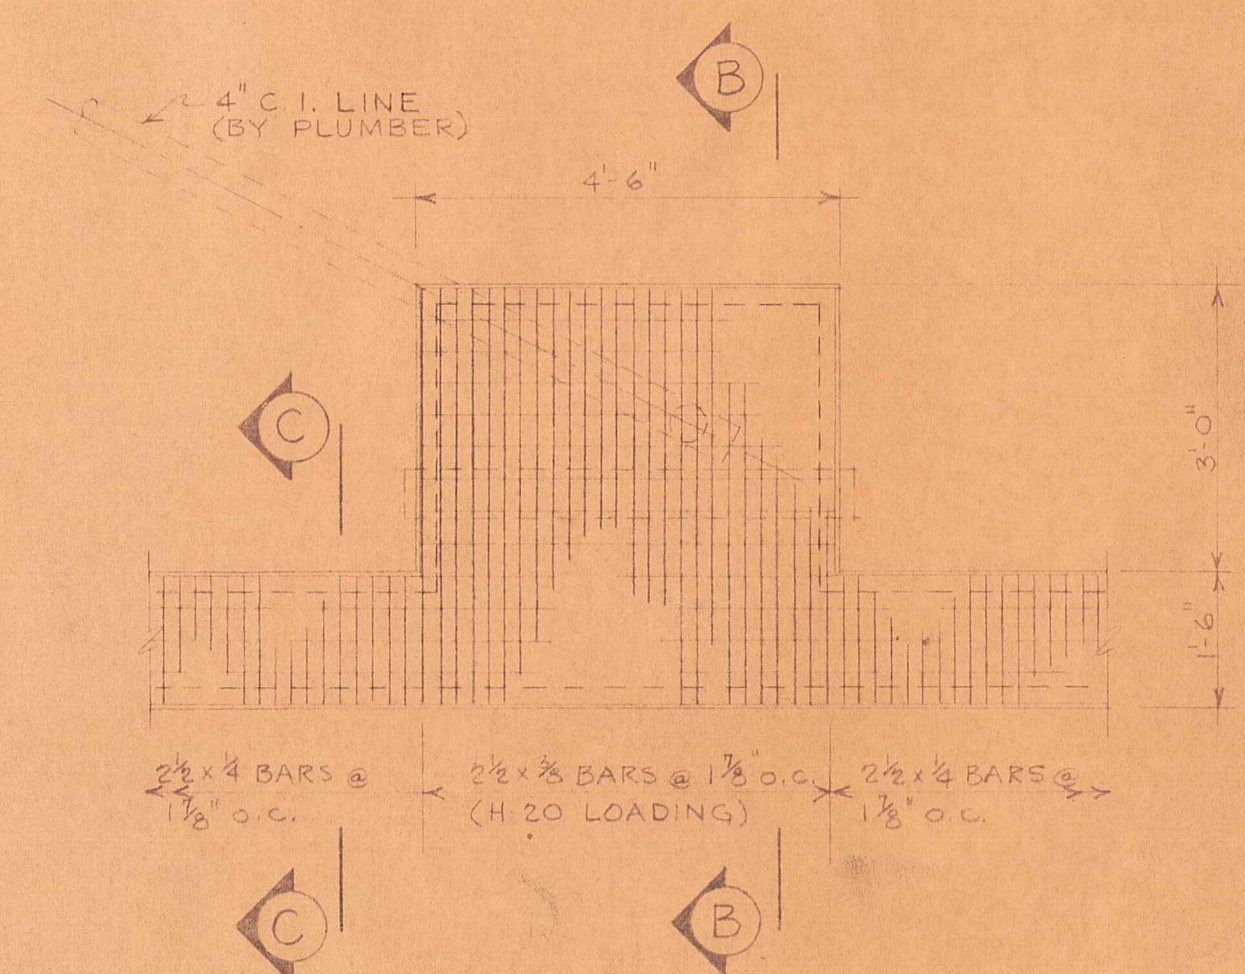

PLAN - SAND TRAP IN EQUIPT. STORAGE
1/2" = 1'-0"

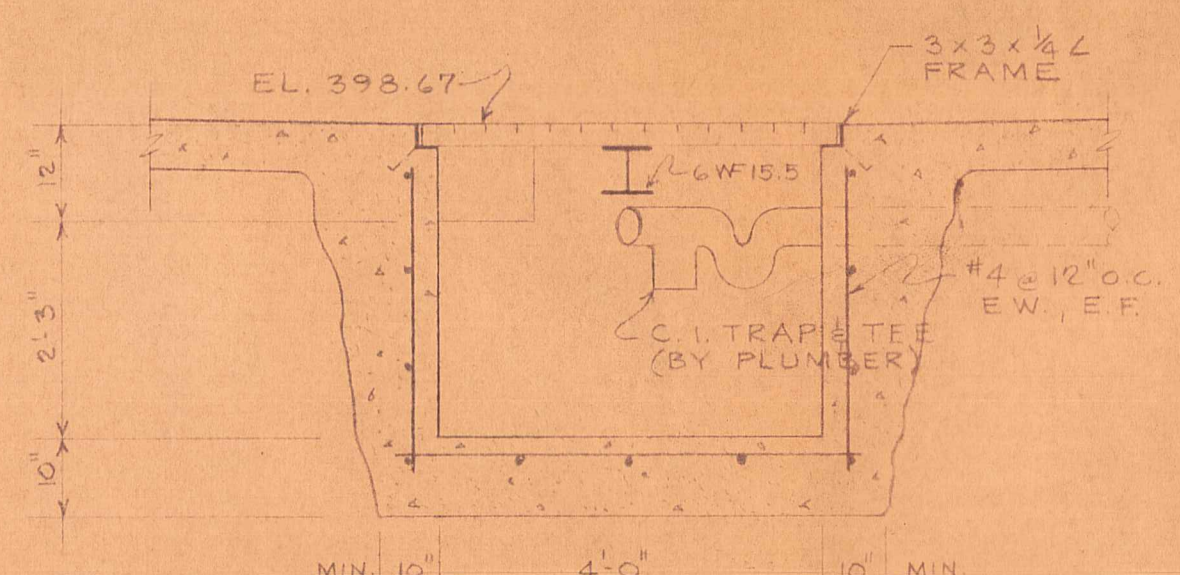

SECTION B-B
1/2" = 1'-0"

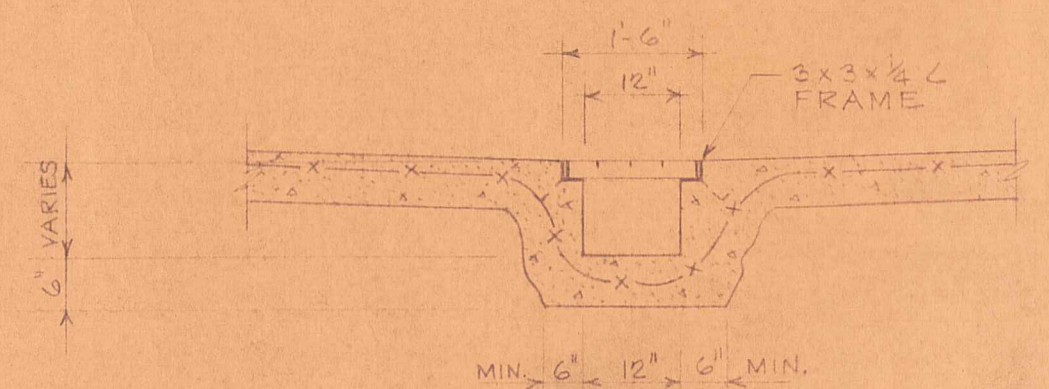

SECTION C-C
1/2" = 1'-0"

AKINS ASSOCIATES
 ENGINEERS SURVEYORS
 PROJECT: WATER POLLUTION CONTROL, WATER SUPPLY, INDUSTRIAL WASTE, INDUSTRIAL BUILDINGS, SEWER, STREET, HIGHWAY
 TOWN OF CANTON, NEW YORK
 CONTRACT NO. 71-07
 DRAWING NO. A-5
 FILE NO. 71-07/6-4-35
 DOOR SCHEDULE & MISC. DETAILS
 AS NOTED